

MUNICIPALITY OF ANCHORAGE
WATER AND WASTEWATER UTILITY

PROVIDENCE-CHESTER CREEK SUBDIVISION TRACT C-2


BASED UPON AWAU'S INTERPRETATION OF THE DESIGN ENGINEER'S INTENT, THIS PLAN APPROVAL IS TO ENSURE THAT THE PLANS WERE DESIGNED TO AWAU'S STANDARDS AND THE SIGNEE IS NOT LIABLE FOR ANY ERRORS OR OMISSIONS.


APPROVED FOR CONSTRUCTION
By Anchorage Water and Westeward Utility

Date 1116 By

PROJECT IDENTIFICATION No. WS15-008 07/29/2015

	SHEET INDEX
SHEET NO.	SUBJECT
1	COVER SHEET
2	ABBREVIATIONS, KEY MAPS, LEGEND AND NOTES
3	SURVEY CONTROL
4	DEMOLITION PLAN
5	WATER PLAN AND PROFILE
6	SANITARY SEWER PLAN & PROFILE

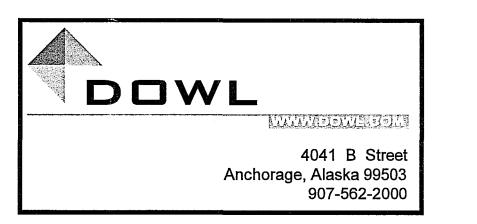

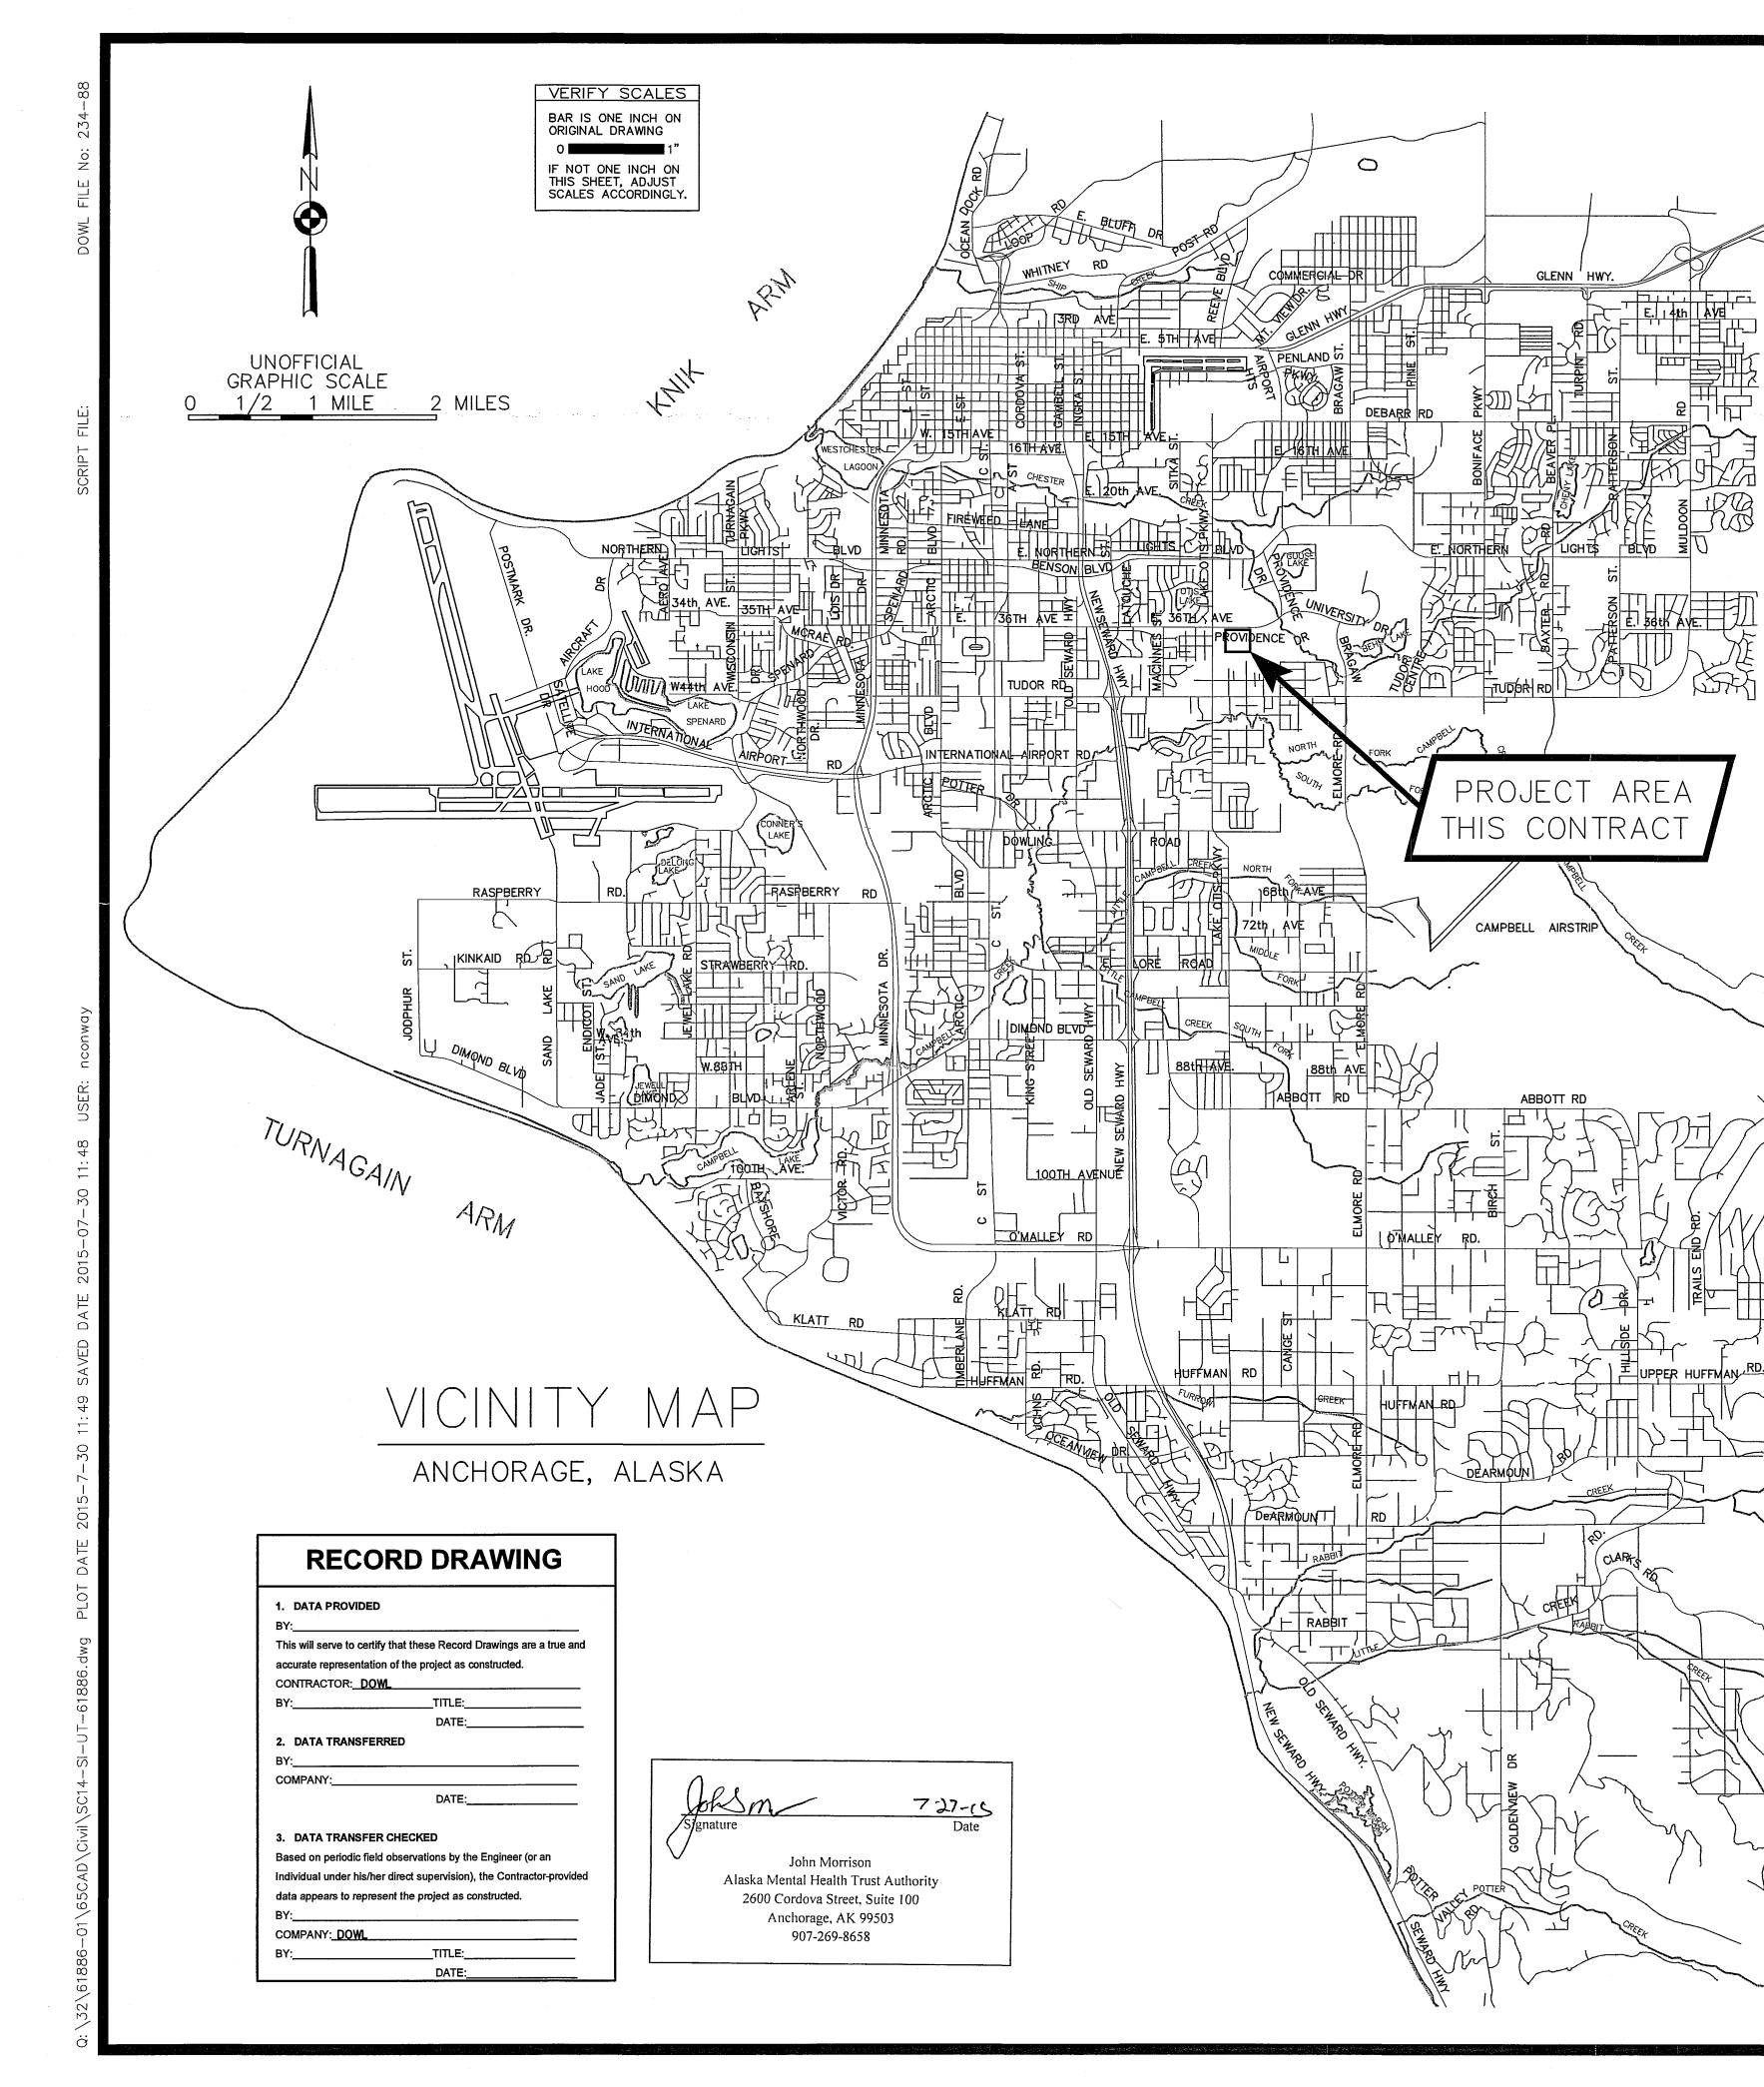

GM GP ML PT SM SM ML SP <u>SP</u> SM SW

QUANTITIES

PLAN CHECK

MUN. FINAL CHECK

VATER

|FULL SIZE SCALE


REVISIONS


RECORD DRAWING Note: To be filled out on original drawings upon project completion 3. Based on periodic field observations by the DATA PROVIDED BY: XXXXX This will serve to certify that these Record Drawings are a true and accurate supervision), the Contractor-provided data

Engineer (or an individual under his/her direct appears to represent the project as constructed DATA TRANSFER CHECKED BY: XXXXX COMPANY: XXXXX _ TITLE: XXXXX

THIS DOCUMENT AND THE IDEAS INCORPORATED HEREIN, AS AN INSTRUMENT OF PROFESSIONAL SERVICE, IS THE PROPERTY OF AWWU AND IS NOT TO BE USED, IN WHOLE OR IN PART, FOR ANY OTHER PROJECT WITHOUT

COMPANY NAME REUSE OF DOCUMENTS 4041 B STREET

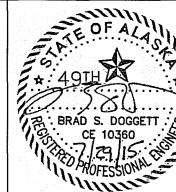

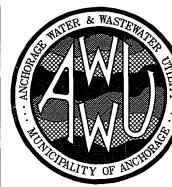

MUNICIPALITY OF ANCHORAGE WATER & WASTE WATER UTILITY

PROVIDENCE - CHESTER CREEK SUBDIVISION TRACT C-2

ABBREVIATIONS, KEYMAPS, LEGEND AND NOTES

HORZ SCALE: N/A DATE: JULY 2015 GRID: SW1734 AWWU PRIVATE DEVELOPMENT #: WS15-008

12/14/2007 🔽 THIS BAR REPRESENTS IF BAR IS NOT ONE **VERIFY** ONE INCH ON ORIGINAL INCH, ADJUST DRAWING HORZ SCALE: N/A SCALE VERT SCALE: DRAWING. SCALE ACCORDINGLY. DRAWN CHECKED DATA DRAWN CHECKED REV DATE DESCRIPTION DATA BY TELEPHONE LECTRIC OPOGRAPHY CABLE TV PROFILE TRAFFIC SIGNAL SANITARY SEWER DESIGN TORM SEWER

representation of the project as constructed. CONTRACTOR: XXXXX ___TITLE: XXXXX DATE: 00/00/00

DATA TRANSFERRED BY: XXXXX

COMPANY: XXXXX

DATE: 00/00/00

DATE: 00/00/00

907-562-2000 WRITTEN AUTHORIZATION OF

AWWU.

ANCHORAGE, AK 99503

CONSULTANT

SEAL

SCALE 1" = 1000'

SURVEY CONTROL NOTES

HORIZONTAL CONTROL

This project is located entirely within the Anchorage Bowl 2000 adjustment, a local surface grid coordinate system expressed in U.S. Survey feet units developed by the Alaska Department of Transportation.

The Basis of Coordinates is NGS Station O'Malley, located near the intersection of the New Seward Highway and O'Malley Road. Said station has Anchorage Bowl 2000 coordinates of 303939.2310 N, 353362.5446 E. U.S. Survey Feet.


The Basis of Bearings is a local plane bearing between NGS Station O'Malley and NGS Station Loop 2 USE RM 3 1964. NGS Station Loop 2 USE RM 3 1964 bears N 01'43'26.4"E a distance of 49488.4476 feet from NGS Station O'Malley. NGS Station Loop 2 USE RM 3 1964 has Anchorage Bowl 2000 coordinates of 353405.2778 N, 354851.3982 E. U.S. Survey Feet.


To convert the local coordinates to NAD83 (92) State Plane coordinates expressed in U.S. Survey Feet, translate using +2296868.6878 N usf, +1312517.4904 E usf, and scale using 0.9998910192.

Elevations are based on the Municipality of Anchorage Vertical Control Network in U.S. Feet. The Basis of Elevation is Benchmark "GAAB-17" having a value of 154.49 feet and "GAAB-101" having a value of 136.22 feet. The datum is NGS 1972 ADJUST.

SURVEY NOTES

- 1. The field survey was performed by DOWL from November 2006 to February 2007, May 2009, and January 2011. Field survey information for this project is located in DOWL HKM Field Book No. 2085, Pages 1 through 67, Field Book No. 2086, Pages 2 through 69, Field Book No. 2087, Pages 1 through 74, Field Book No. 2090, Pages 1 through 76, Field Book No. 2097, Pages 1 through 27 and 63 through 64, Field Book No. 2099, Pages 63 through 69.
- 2. All distances are ground distances reduced to horizontal in U.S. Feet.
- 3. Feet to Meter conversion factor is 1200/3937.
- 4. Background property information shown hereon is based on plats, deeds, or record of surveys researched for this project and is shown for orientation purposes only.
- 5. Whether listed or not, all monuments or property markers, corners, or accessories which will be disturbed or buried, shall be referenced and reestablished in their original position (AS 19.10.260) and recorded (AS 34.65.040).
- 6. Underground Natural Gas, Telephone, Electric, and Cable TV lines were
- 7. Location of water utility lines is approximate. They are drawn from valve to valve using As—Built information and were not field located.

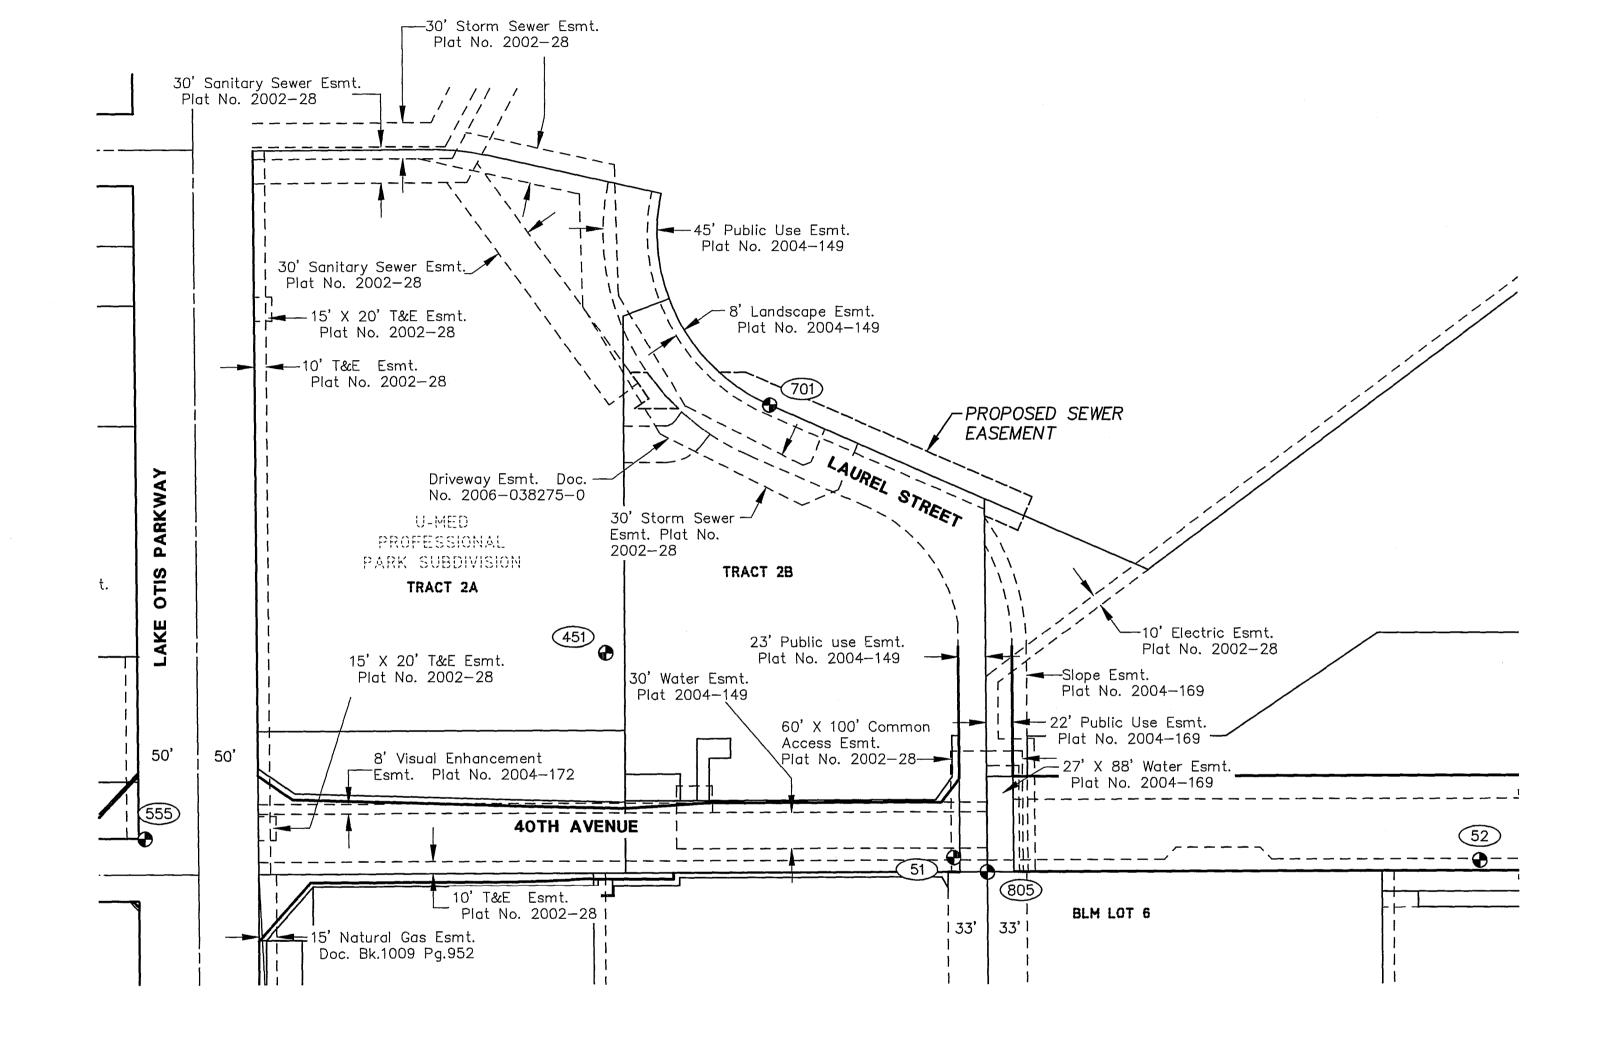

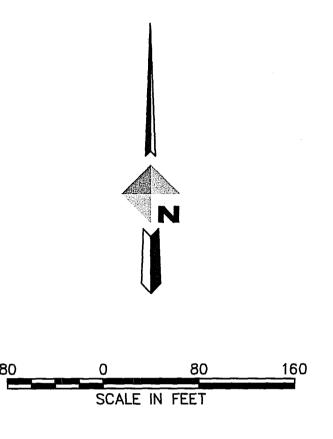

LEGEND SURVEY MONUMENT CONTROL POINT NUMBER

ADJACENT PROPERTY ----- ROW CENTERLINE --- -- -- EASEMENT

SURVEY CONTROL POINTS POINT NORTHING EASTING ELEVATION DESCRIPTION 328,296.68 357,265.23 — 328,294.23 357,705.13 — Alum. Cap Alum. Cap
 451
 328,465.90
 356,974.69

 555
 328,313.07
 356,589.00

 701
 328,670.26
 357,112.26

 805
 328,284.71
 357,293.52
 Alum. Cap Brass Cap Alum. Cap Alum. Cap

> eased upon awwu's interpretation of the design engineer's intent, this plan approval is to ensure that the plans were designed to AWWU'S STANDARDS AND THE SIGNEE IS NOT LIABLE FOR ANY ERRORS OR OMISSIONS.

APPROYED FOR CONSTRUCTION By Anchorage Water and Wester Stillity

VERIFY THIS BAR REPRESENTS ONE INCH ON ORIGINAL O"I DRAWING.						1"			IF BAR IS NOT ONE INCH, ADJUST DRAWING SCALE ACCORDINGLY.	FULL SIZE SCALE HORZ SCALE: 1"=80' VERT SCALE:		RECORD DRAWING 1. DATA PROVIDED BY: XXXXX
DATA	DRAWN BY	CHECKED	DATA	DRAWN BY	CHECKED	REV	DATE		DESCRIPTION		BY	This will serve to certify that the Drawings are a true and accurate
BASE			TELEPHONE									representation of the project as
TOPOGRAPHY			ELECTRIC									CONTRACTOR: XXXXX
PROFILE			CABLE TV									BY:TITLE: XX
SANITARY SEWER			TRAFFIC SIGNAL									DATE: <u>00/00/00</u>
STORM SEWER			DESIGN		<u> </u>			<u> </u>				2. DATA TRANSFERRED BY: XXXXX
WATER			QUANTITIES		<u> </u>							COMPANY: XXXXX
GAS		<u>L</u>	MUN. FINAL CHECK		<u> </u>	<u> </u>			DEVICIONO			DATE: 00/00/00
PLAN CHECK				Į.	REVISIONS					U/\ L		

RECORD DRAWING Note: To be filled out on original drawings upon project completion. DATA PROVIDED BY: XXXXX 3.Based on periodic field observations by the This will serve to certify that these Record Drawings are a true and accurate representation of the project as constructed. CONTRACTOR: XXXXX ___TITLE: XXXXX DATE: 00/00/00

Engineer (or an individual under his/her direct supervision), the Contractor-provided data appears to represent the project as constructed. AS AN INSTRUMENT OF DATA TRANSFER CHECKED BY: XXXXX COMPANY: XXXXX ____ TITLE: XXXXX

DATE: 00/00/00

THIS DOCUMENT AND THE IDEAS INCORPORATED HEREIN, PROFESSIONAL SERVICE, IS THE PROPERTY OF AWWU AND IS NOT TO BE USED, IN WHOLE OR IN PART, FOR ANY OTHER PROJECT WITHOUT 907-562-2000 WRITTEN AUTHORIZATION OF

AWWU.


REUSE OF DOCUMENTS

4041 B STREET ANCHORAGE, AK 99503

CONSULTANT

COMPANY NAME

A. WILLIAM STOLL SEAL

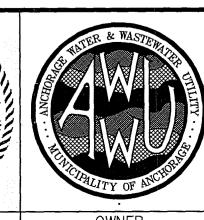

MUNICIPALITY OF ANCHORAGE WATER & WASTE WATER UTILITY

PROVIDENCE - CHESTER CREEK SUBDIVISION TRACT C-2

SURVEY CONTROL

HORZ SCALE: 1"=80' DATE: JULY 2015 GRID: SW1734 AWWU PRIVATE DEVELOPMENT #: WS15-008

